



### INDRADHANUSH GAS GRID LIMITED (IGGL)

(Joint Venture of IOCL, ONGC, GAIL, OIL and NRL) **GUWAHATI, ASSAM** 

# NORTH -EAST GAS GRID PIPELINE PROJECT

### **BID DOCUMENT FOR**

COMPOSITE WORKS (ELECTRICAL & INSTRUMENTATION, CIVIL) FOR NEGDCL PIPELINE CONNECTIVITY UNDER NORTH EAST GAS GRID (NEGG) PROJECT OF M/S INDRADHANUSH GAS GRID LIMITED (IGGL)

## **OPEN DOMESTIC COMPETITIVE BIDDING**

Tender ID: 2025 IGGL 242270 1

Bid Document No.: 05/51/23VC/IGGL/001(NEGDCL)-R1

**VOLUME – III OF III** 



# PREPARED AND ISSUED BY MECON LIMITED


(A Govt. of India Undertaking) Delhi, India


# TENDER DRAWINGS-SINGLE LINE DIAGRAM (SLD) (ELECTRICAL SYSTEM)


IGGL IGGL	OIL & GAS SBU	COMPOSITE WORKS (ELECTRICAL & INSTRUMENTATION, CIVIL) FOR NEGDCL PIPELINE CONNECTIVITY	MECON LTD, DELHI		
TITLE	TABLE OF CONTENT	DOCUMENT NO.	Page 1 of 1		
	(ELECTRICAL SYSTEM)		REVISION 0		

# **TABLE OF CONTENT**

Sl No.	Description	Document No./ Drawing No.	Rev. No.								
	DESIGN BASIS, SCOPE OF WO ECTRICAL SYSTEM	RK, QAP, PJS & STANDARDD DATASH	IEETS								
1	Scope of Work for Electrical system	MEC/23UU/05/E9/E/001	Rev. 0								
2	Electrical Check List	-	Rev. 0								
3	List of Tool Kits and instruments- Annexure A	-	Rev. 0								
4	List of Suppliers of Major bought out items	-	Rev. 0								
5	Inspection Categorization plan for electrical items	-	-								
6	Quality Assurance Plan for Electrical system	MEC/05/E9/23UU/QAP/01	Rev. 0								
7	Standard Datasheets of Electrical System	-	-								
VOL-II	: STANDARD SPECIFICATIONS	OF ELECTRICAL SYSTEM	•								
8	Standard Specification of Electrical System	-	-								
VOL-II	OL-III: TENDER DRAWINGS & STANDARD DRAWINGS OF ELECTRICAL SYSTEM										
9	Tender Drawings of Electrical System-Single line diagram	MEC/23UU/05/E9/E/1081	0								
10		MEC/23VC/05/E9/E/1082	0								
11	Typical Equipment Layout for Receiving Facility, NEGDCL	MEC/23VC/05/E9/E/NEGDCL/EQUIPMENT LAYOUT	0								
12	Standard Drawings of Electrical System	-	-								

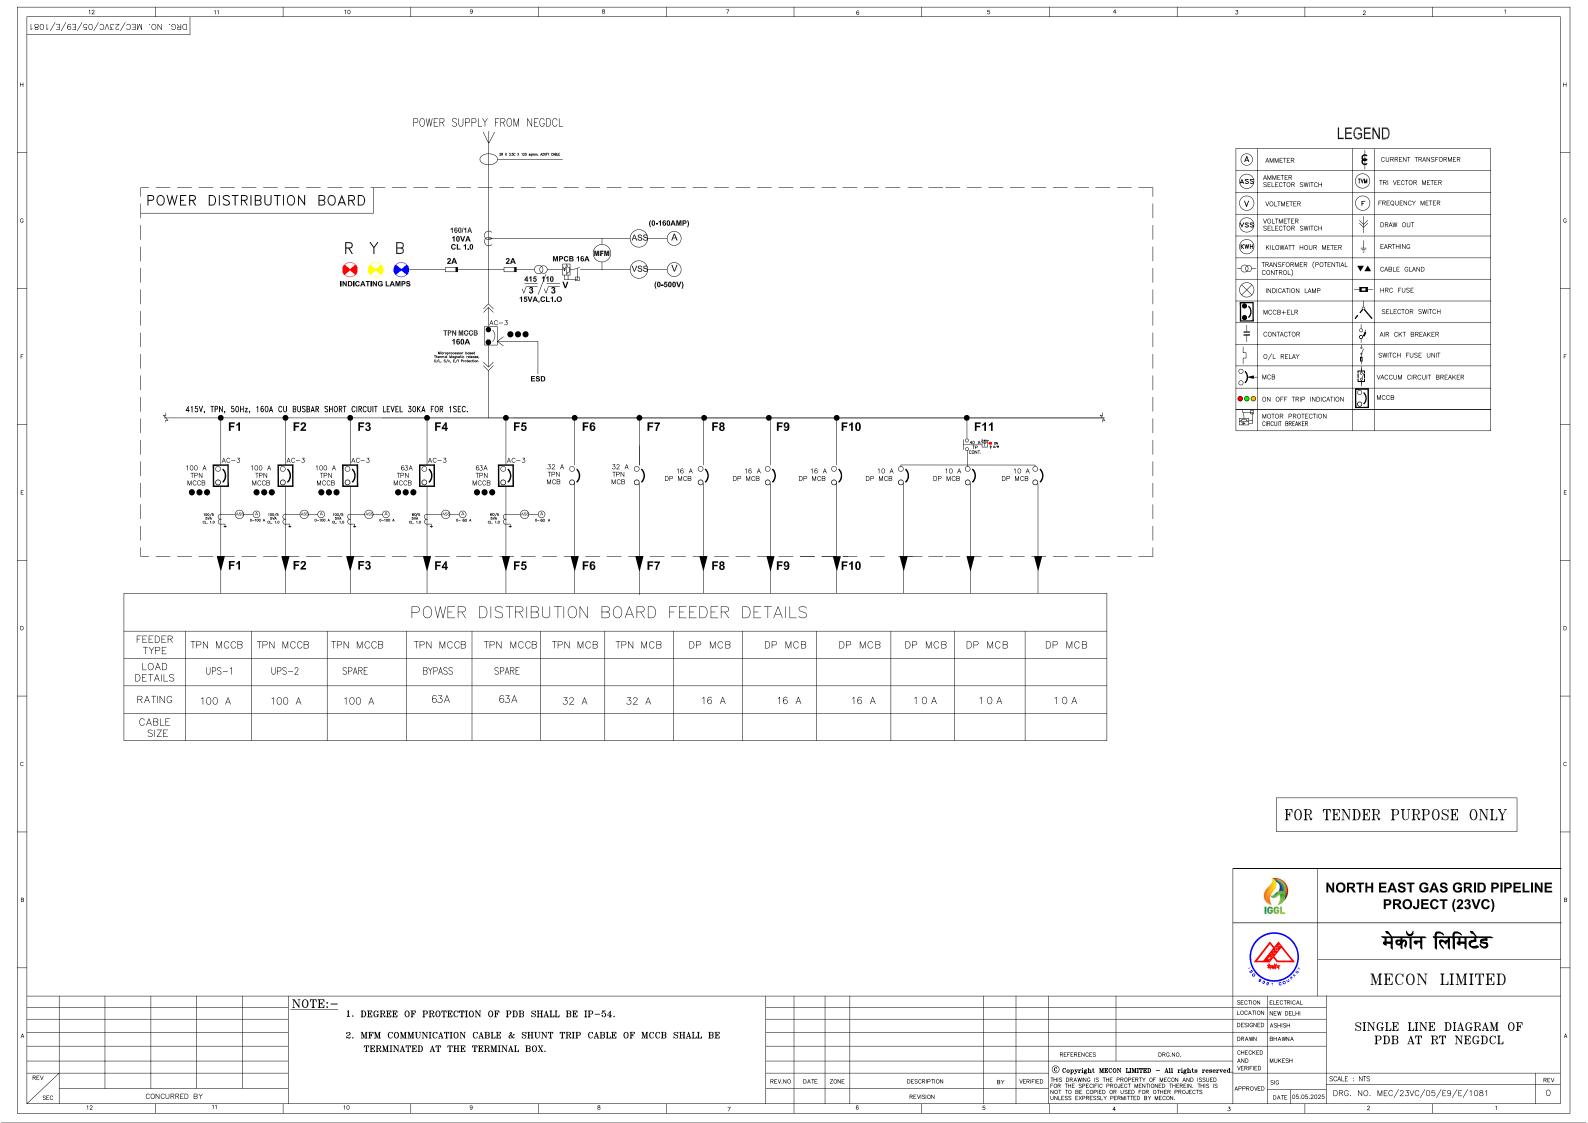

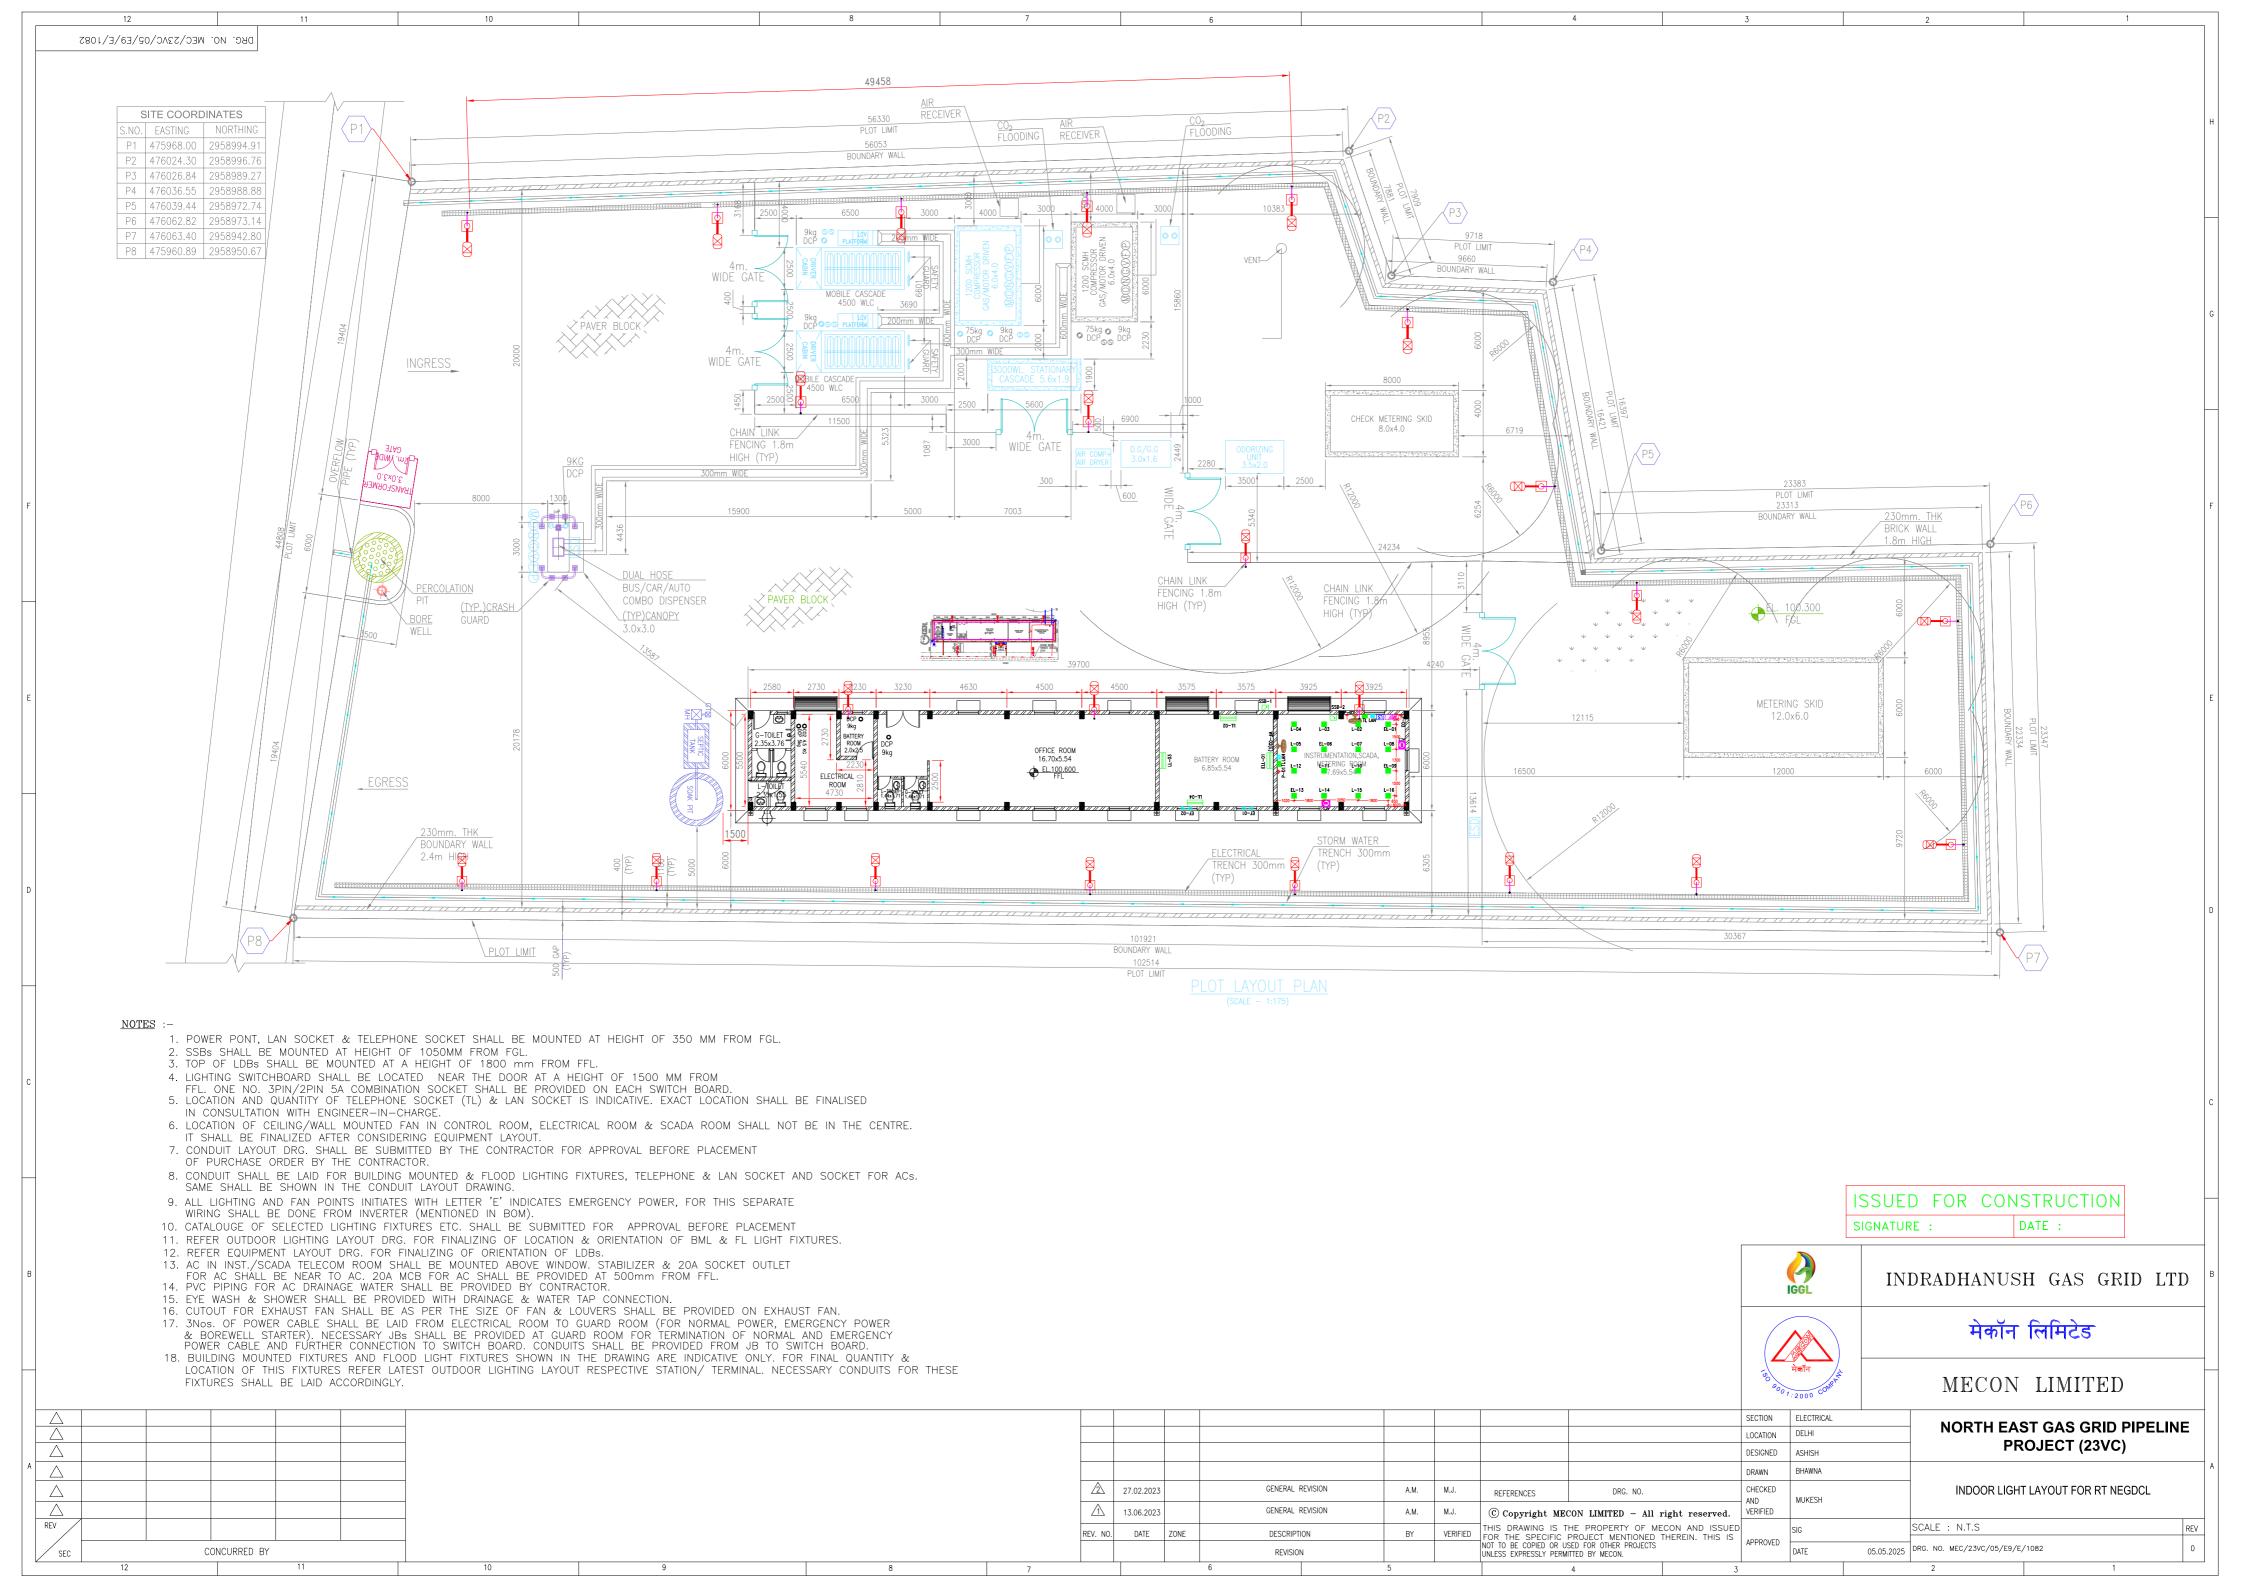

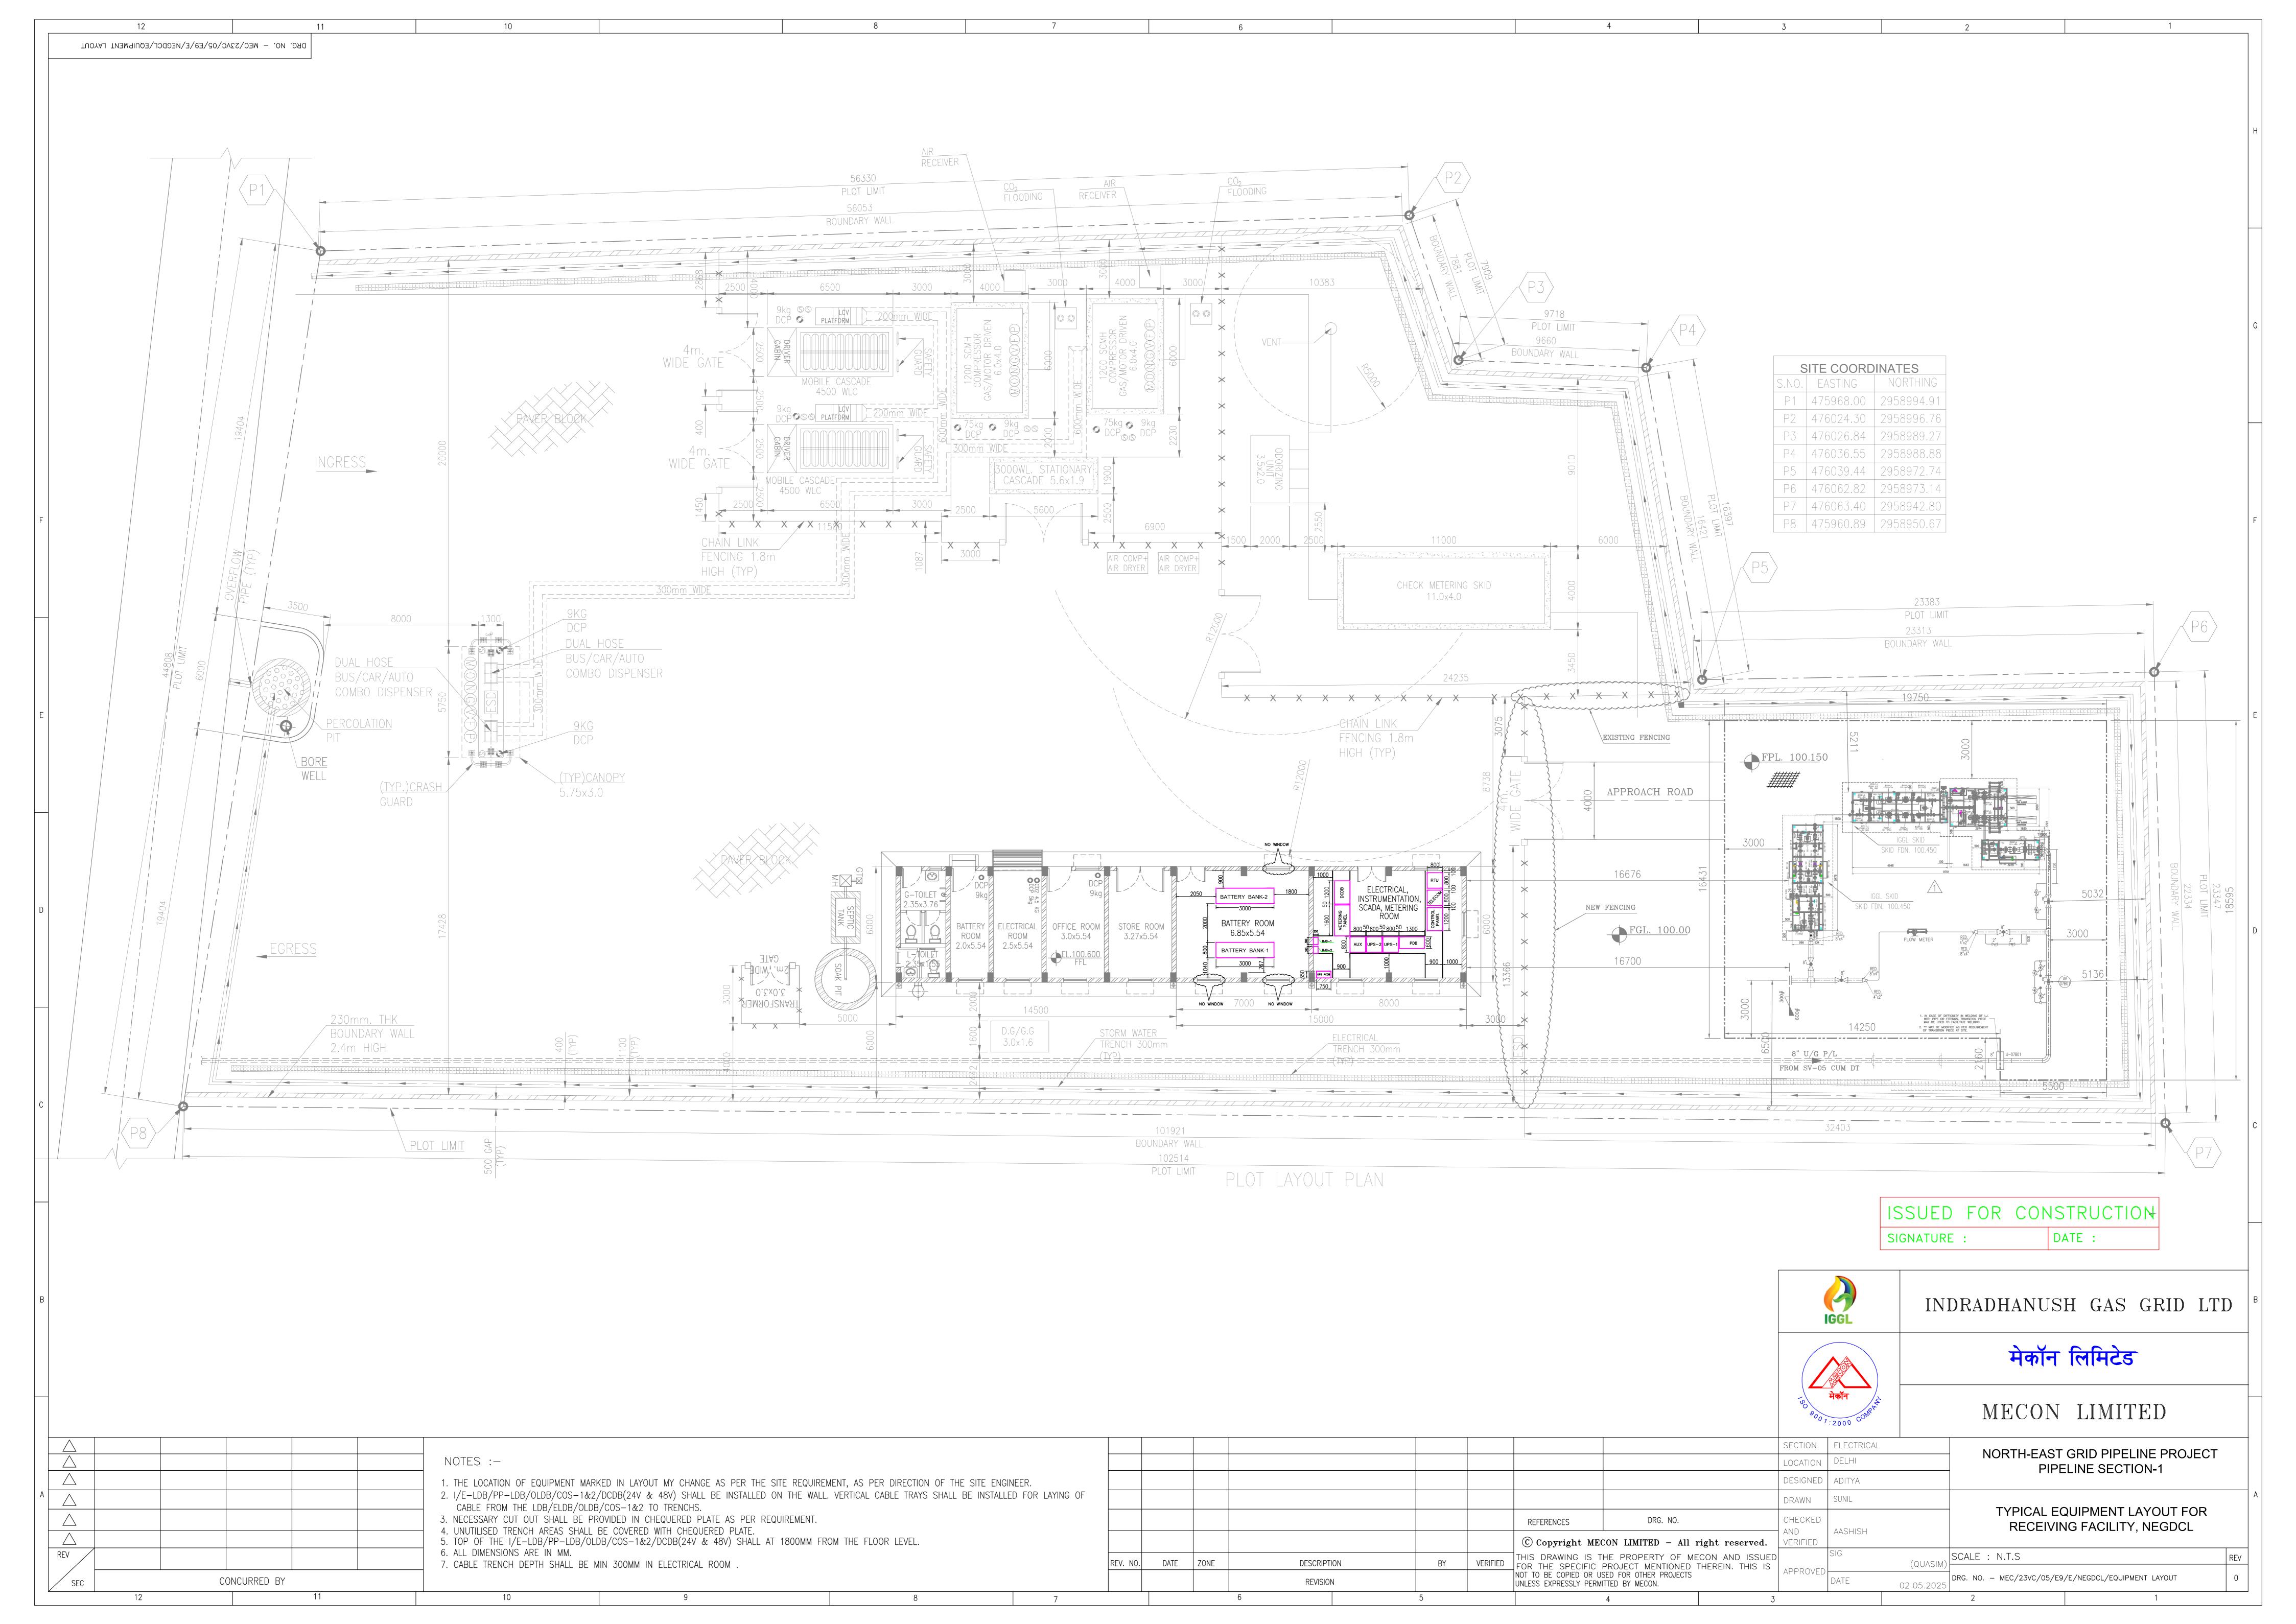


# STANDARD DRAWINGS (ELECTRICAL)


IGGL IGGL	OIL & GAS SBU	NORTH EAST GAS GRID PIPELINE PROJECT SV-5 to RT NEGDCL CONNECTIVITY	MECON LTD, DELHI
TITLE	LIST OF STANDARD		Page 1 of 1
	DRAWINGS		REVISION 0

# **LIST OF STANDARD DRAWINGS (ELECTRICAL)**


SI. No.	Description of Drawings	Drawings No.
1	MARKING OF TRENCHES FOR ELECTRIC CABLES	MEC/SD/05/E9/01/01
2	TYPICAL SECTION OF CABLE TRENCH IN UNPAVED AREAS	MEC/SD/05/E9/01/02
3	EARTH ELECTRODE IN TEST PIT	MEC/SD/05/E9/02/01
4	COPPER PLATE ELECTRODE IN TEST PIT	MEC/SD/05/E9/02/02
5	TYPICAL EARTH CONNECTION FOR STREET LIGHT POLE	MEC/SD/05/E9/02/03
6	EARTHING OF TANKS AND VESSELS	MEC/SD/05/E9/02/04
7	EARTHING METHOD FOR PROCESSING EQUIPMENT	MEC/SD/05/E9/02/05
8	TYPICAL INSTALLATION OF POLE MOUNTED STREET LIGHTING FIXTURE FOR SAFE AREA (WITHOUT RUNGS)	MEC/SD/05/E9/03/01
9	TYPICAL INSTALLATION OF FLOOD LIGHTING POLE (WITH RUNGS)	MEC/SD/05/E9/77/02
10	DIV.2 / FLAME PROOF LIGHTING FIXTURE MOUNTING DETAILS	MEC/SD/05/E9/77/03
11	TYPICAL INSTALLATION OF LIGHTING FIXTURES ON GI OCTOGONAL POLE.	MEC/SD/05/E9/77/04 Sheet 1 of 3
12	TYPICAL INSTALLATION OF LIGHTING FIXTURES ON GI OCTOGONAL POLE.	MEC/SD/05/E9/77/04 Sheet 2 of 3
13	TYPICAL INSTALLATION OF LIGHTING FIXTURES ON GI OCTOGONAL POLE.	MEC/SD/05/E9/77/04 Sheet 3 of 3

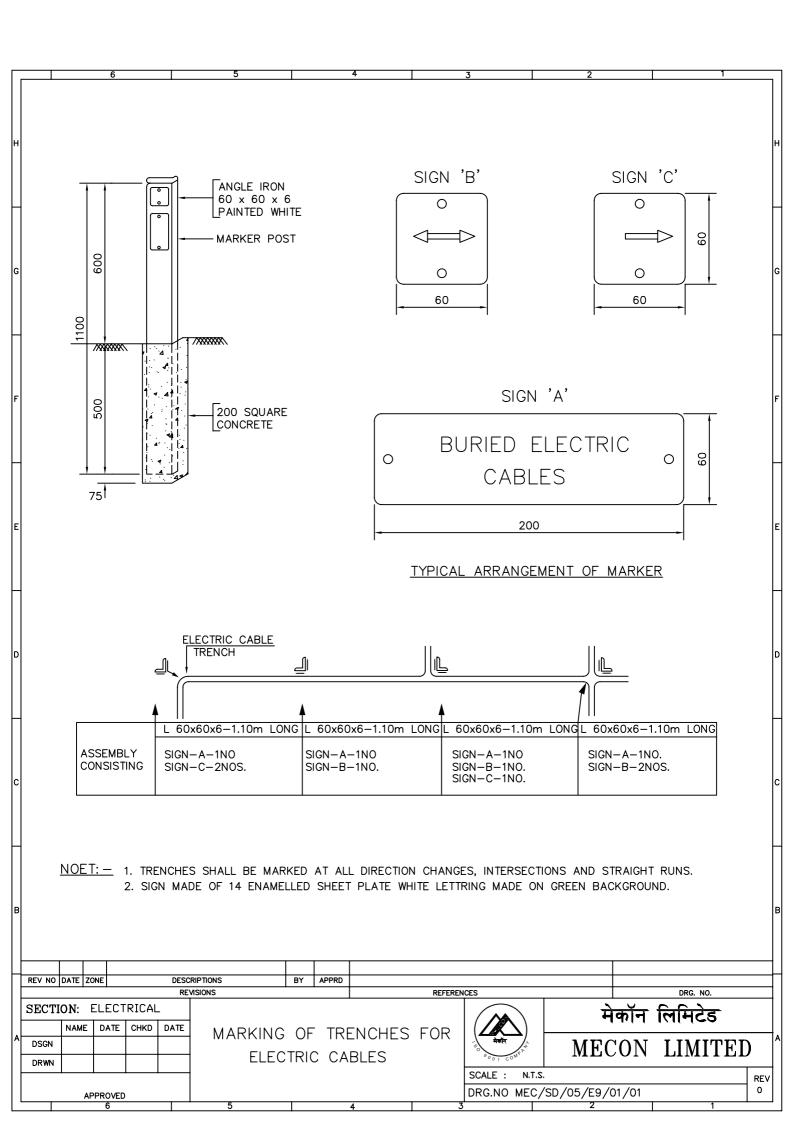

# TYPICAL SECTION WITH H. T. CABLES AND L T CABLES

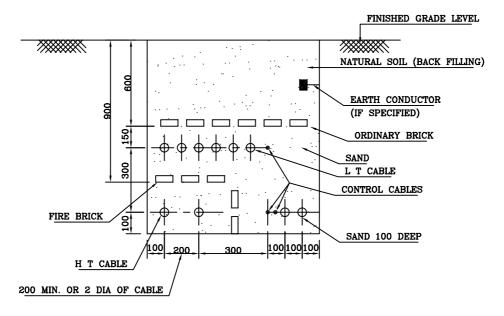



# TYPICAL SECTION WITH L T CABLES ONLY

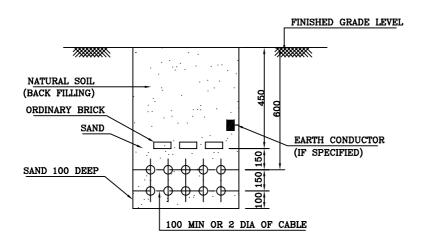



#### NOTES:-


- 1. LEAVE SPACE FOR LATER ADDITION OF AT LEAST 2 CABLES OR 15% AVERAGE SPACE REGARDLESS OF FUTURE EXPANSION.
- 2. IF TELEPHONE CABLES ARE LAID IN THE SAME TRENCH A CLEARANCE OF 300mm SHALL BE BE PROVIDED BETWEEN POWER AND TELEPHONE CABLES.

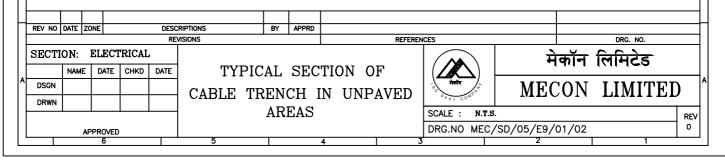


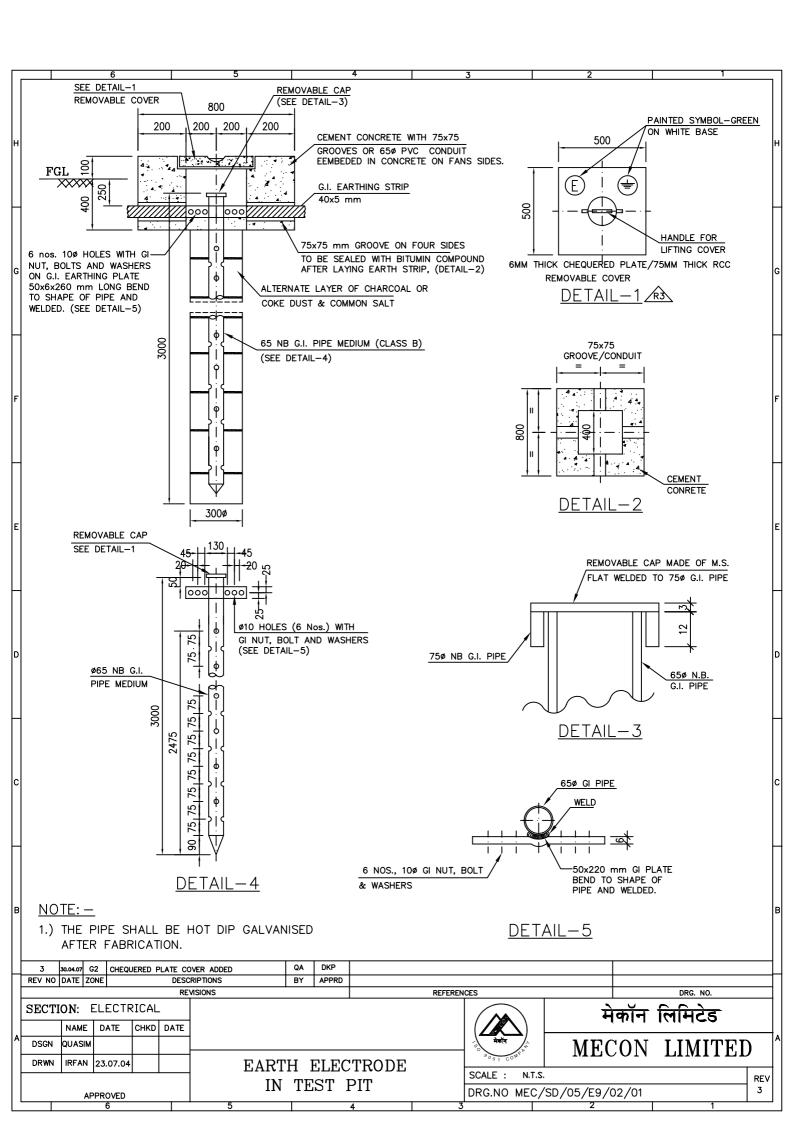


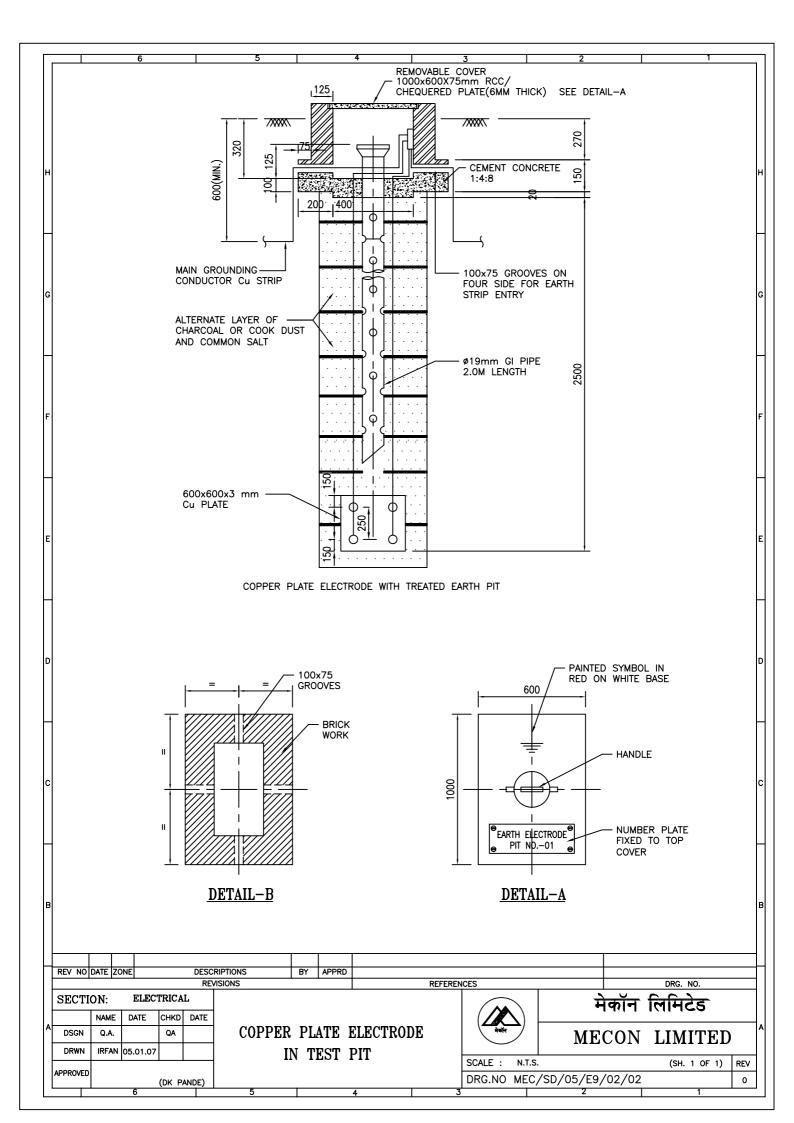


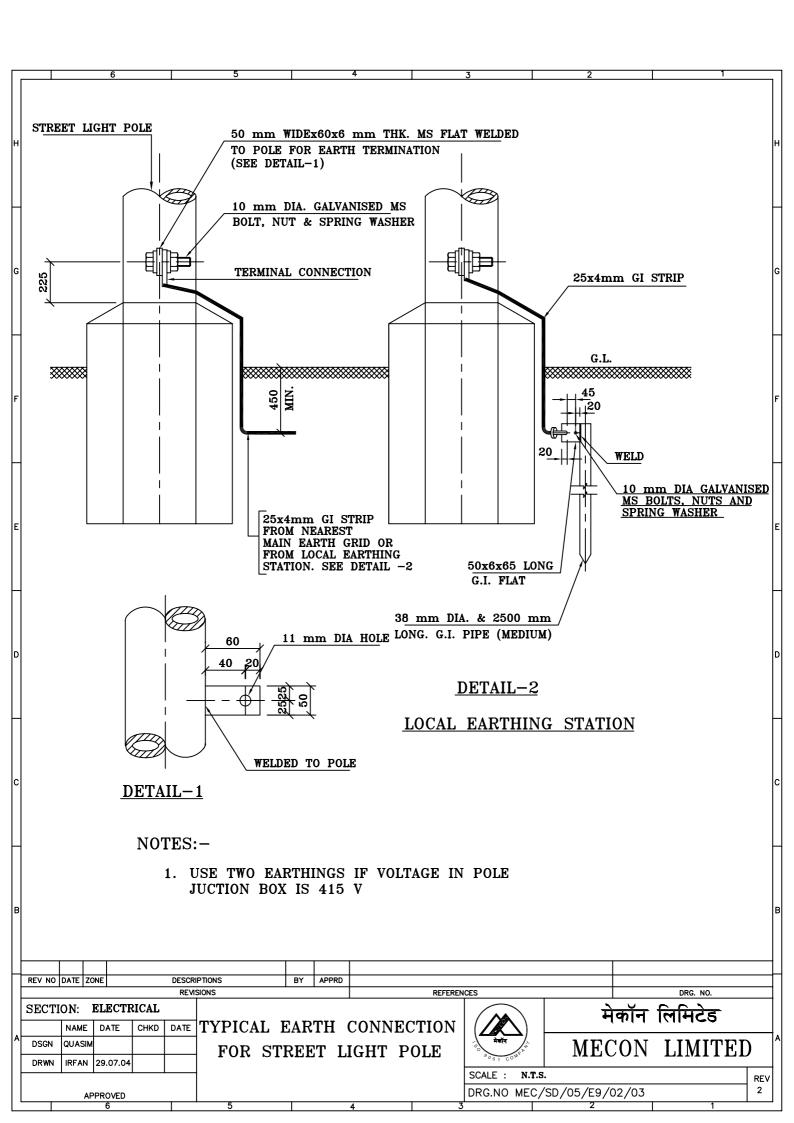


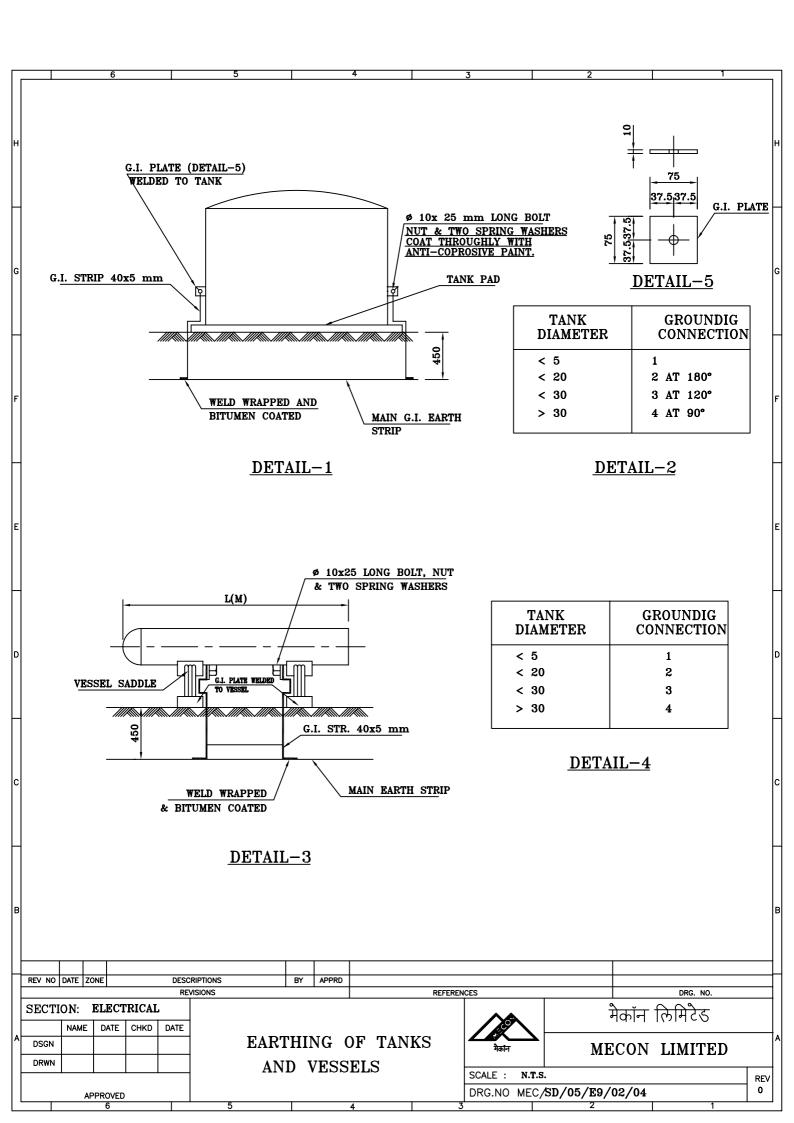


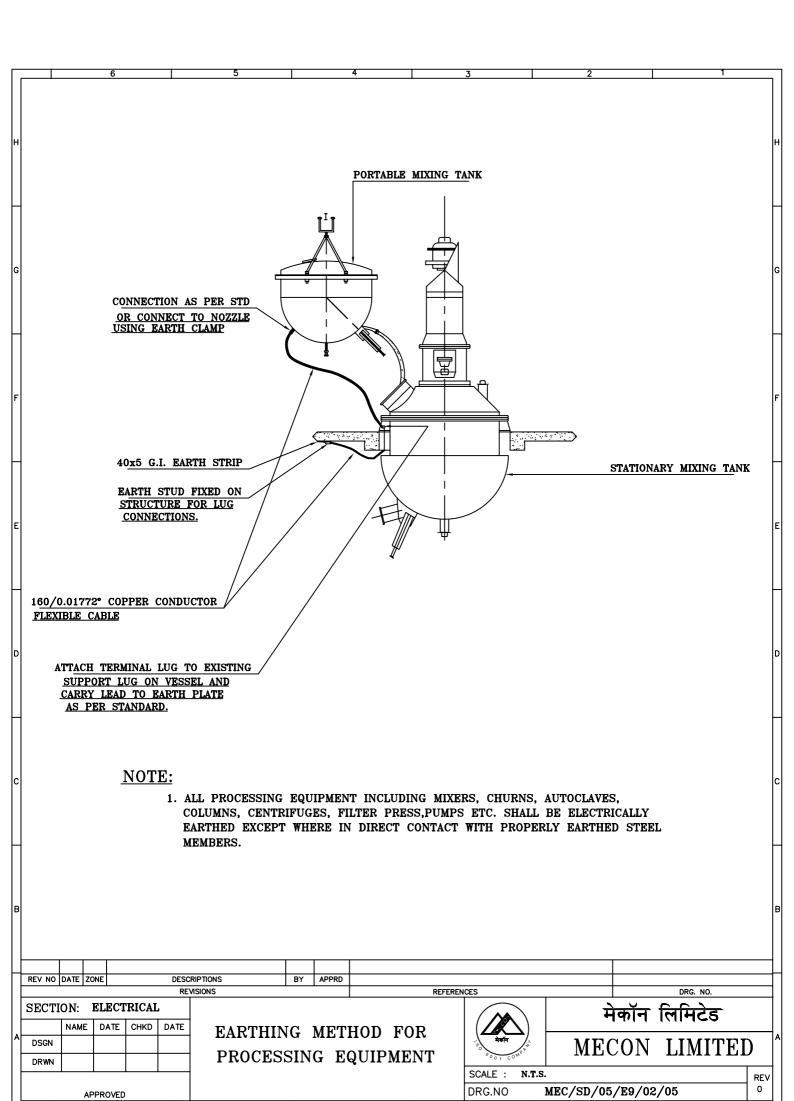


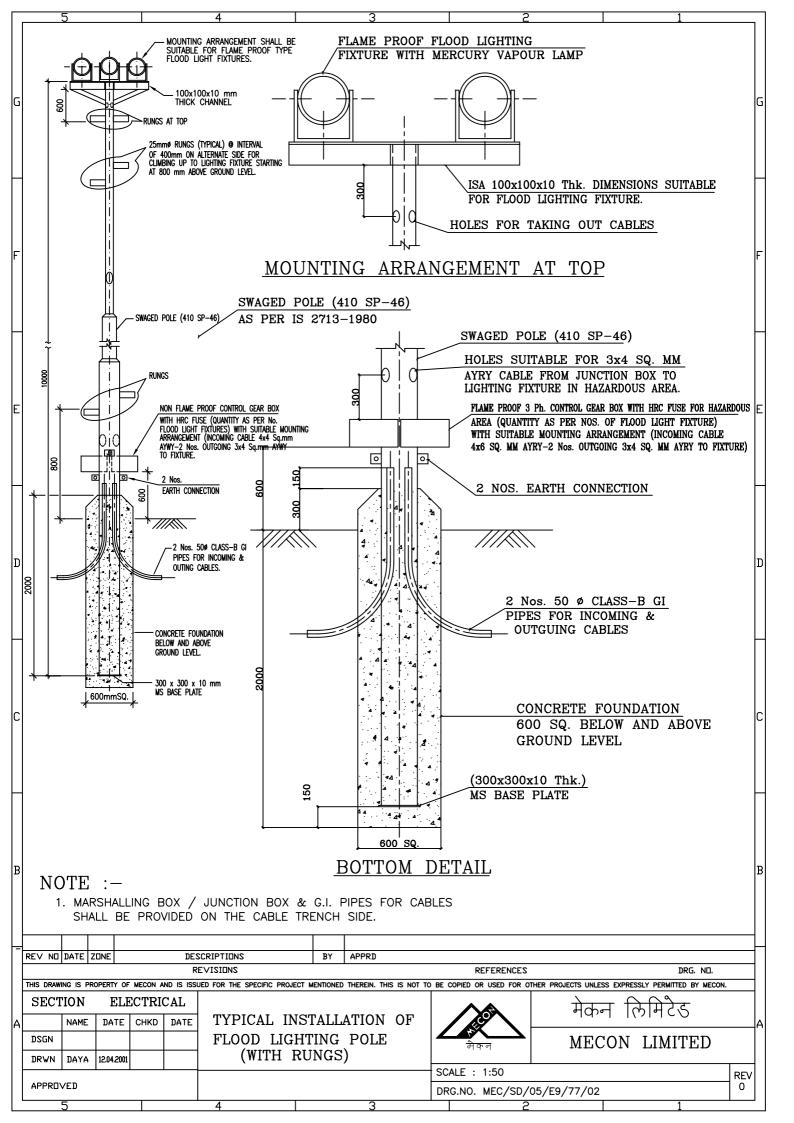


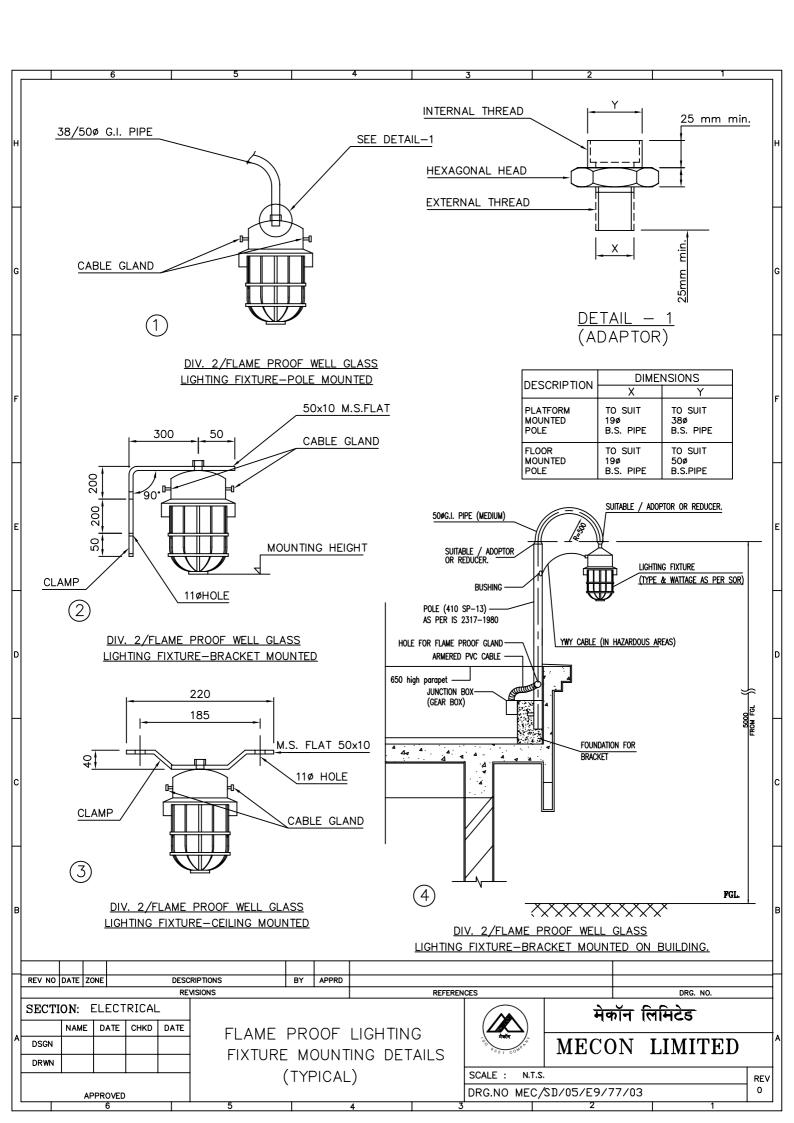

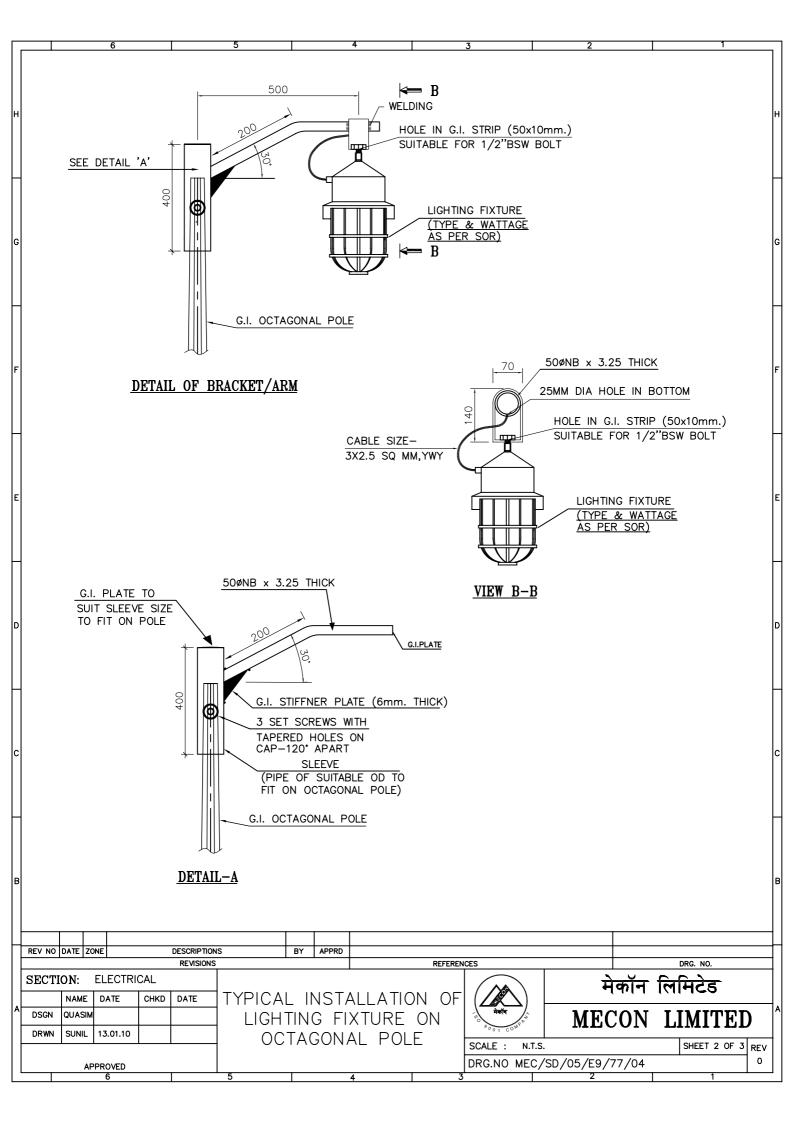

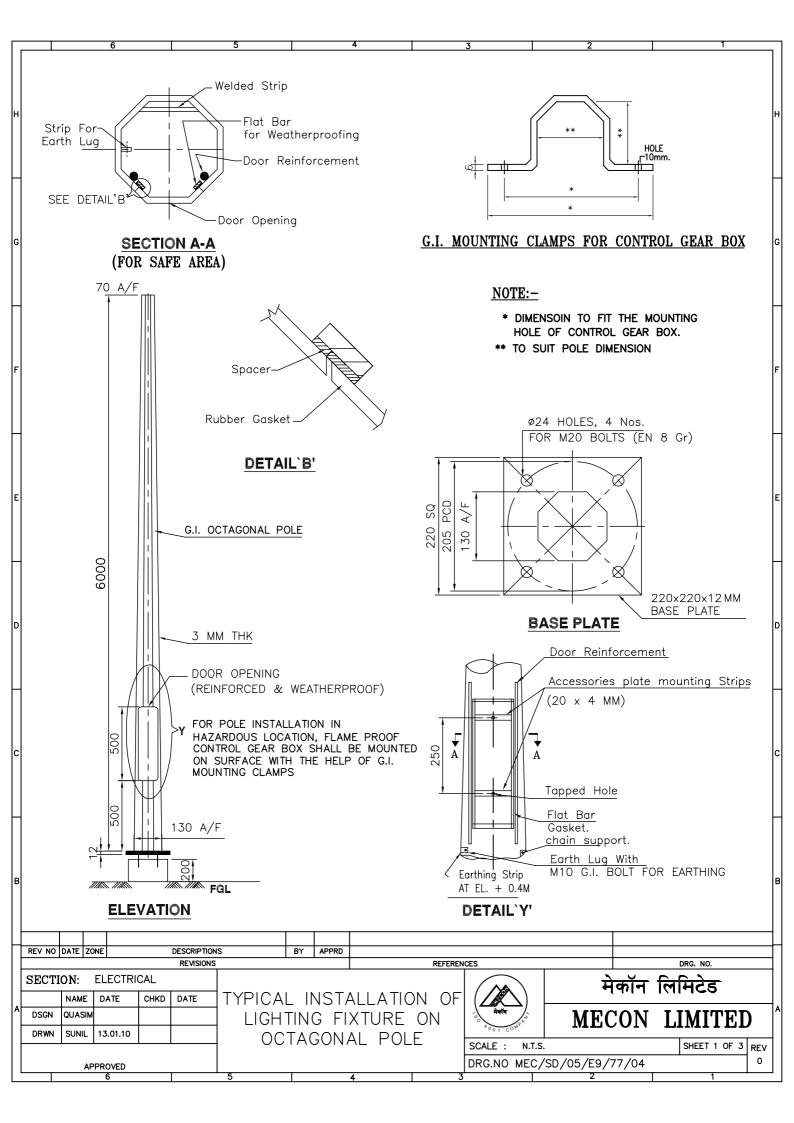

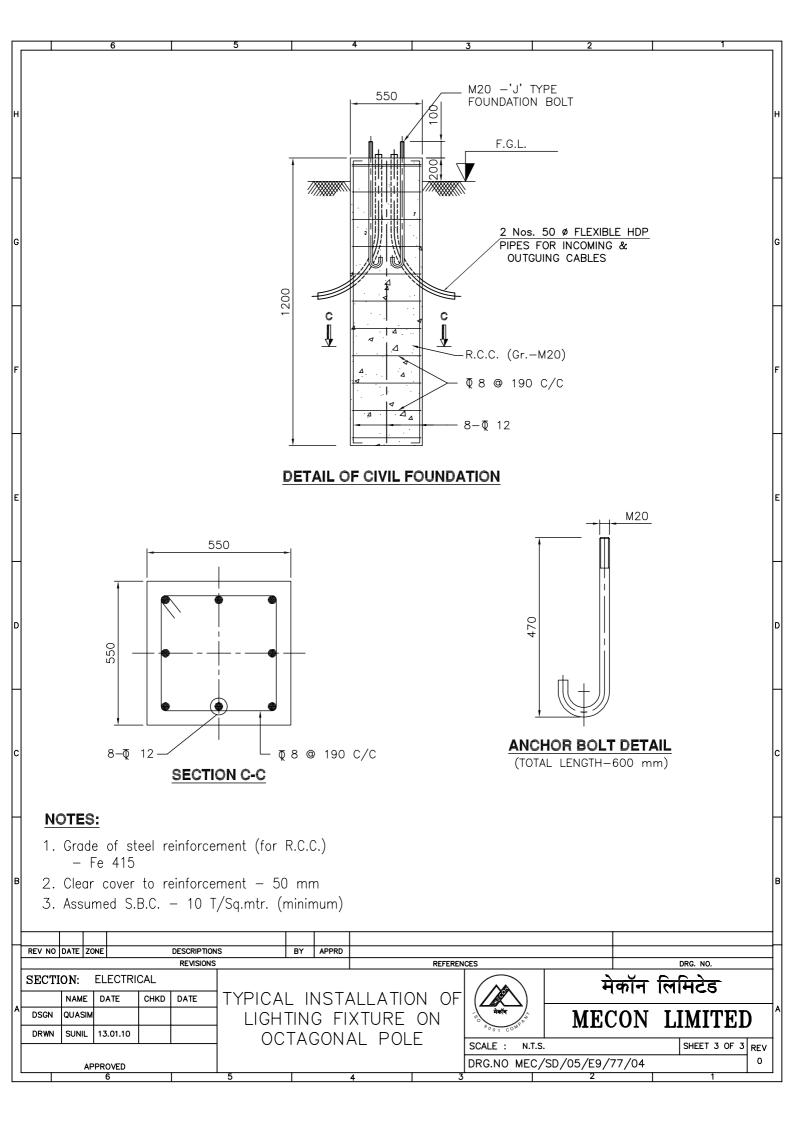


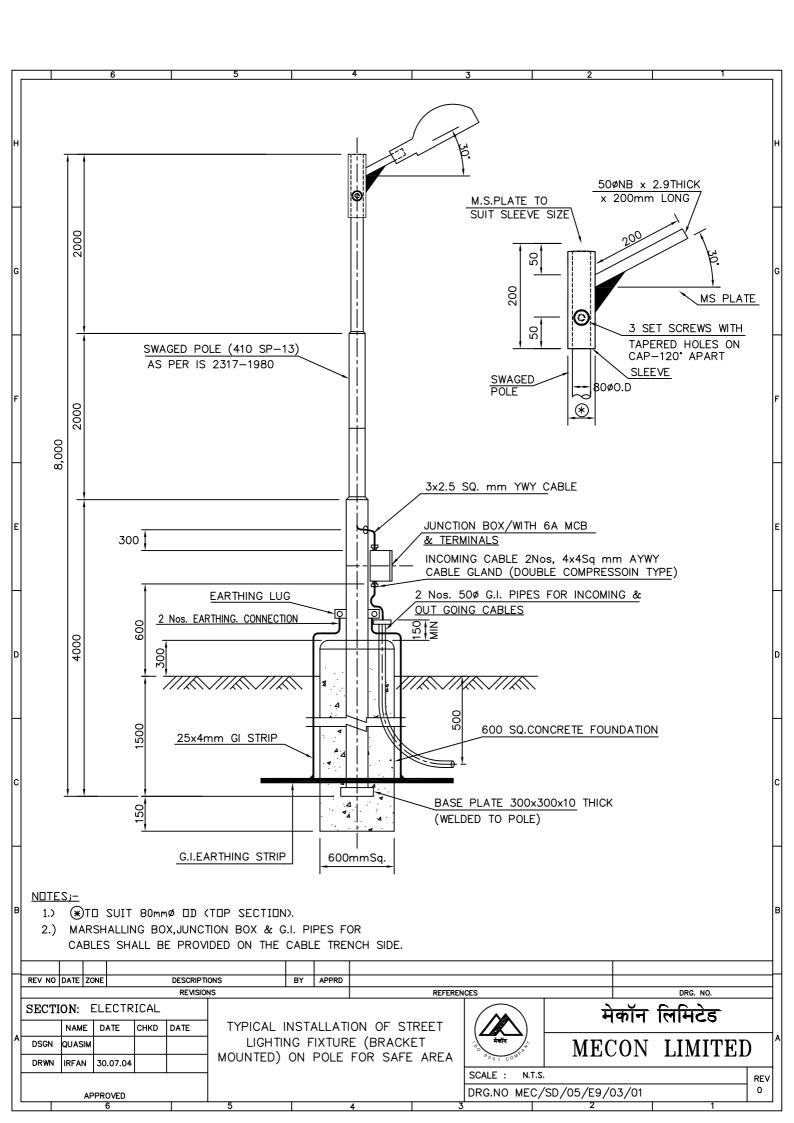



# STANDARD DRAWINGS (INSTRUMENTATION WORKS)


# **LIST OF DRAWINGS**


SI.NO	DESCRIPTION	DRG. NO.				
1.	Installation diagram for Pressure Transmitter	MEC/05/E5/SD/PT/001				
2.	Support Details For Junction Box	MEC/05/E5/SD/JB/009				
3.	Instrument Support Single Instrument	MEC/05/E5/SD/IS/010A				
4.	Instrument Support Two Instrument	MEC/05/E5/SD/IS/010 B				
5.	Fabricated Canopy for Instruments	MEC/05/E5/SD/CY/011				
6.	Perforated Tray Supports & Cable Clamping details	MEC/05/E5/SD/CBLY/012				

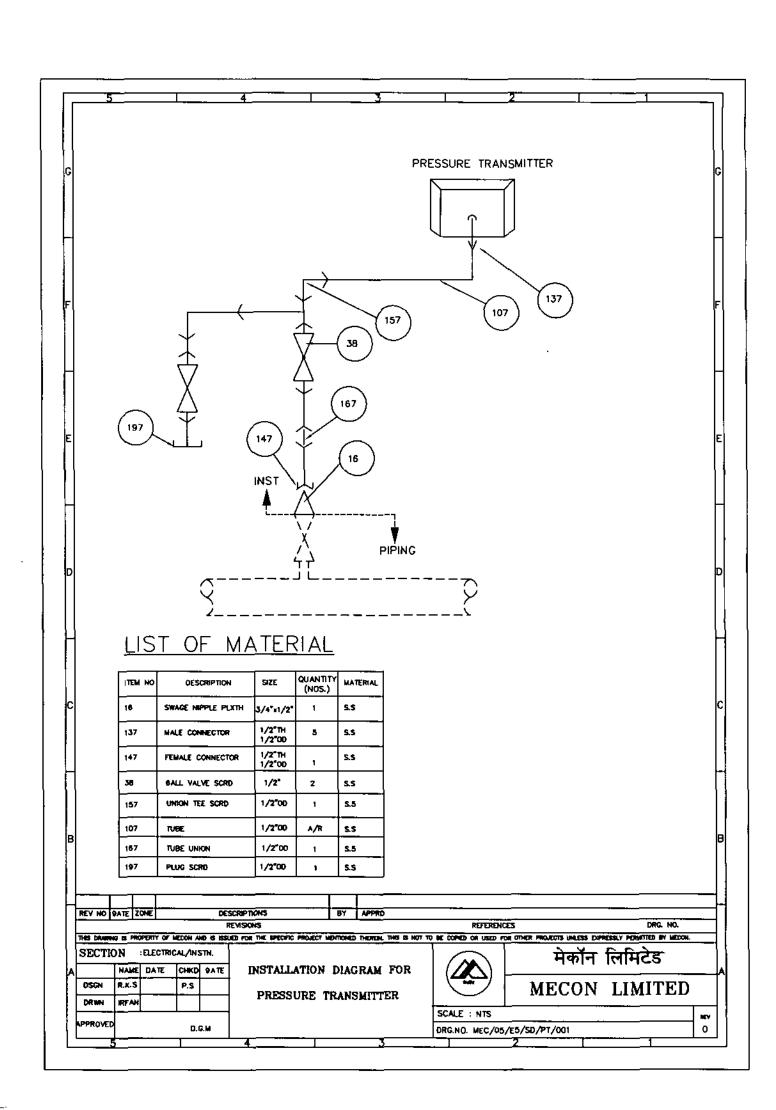


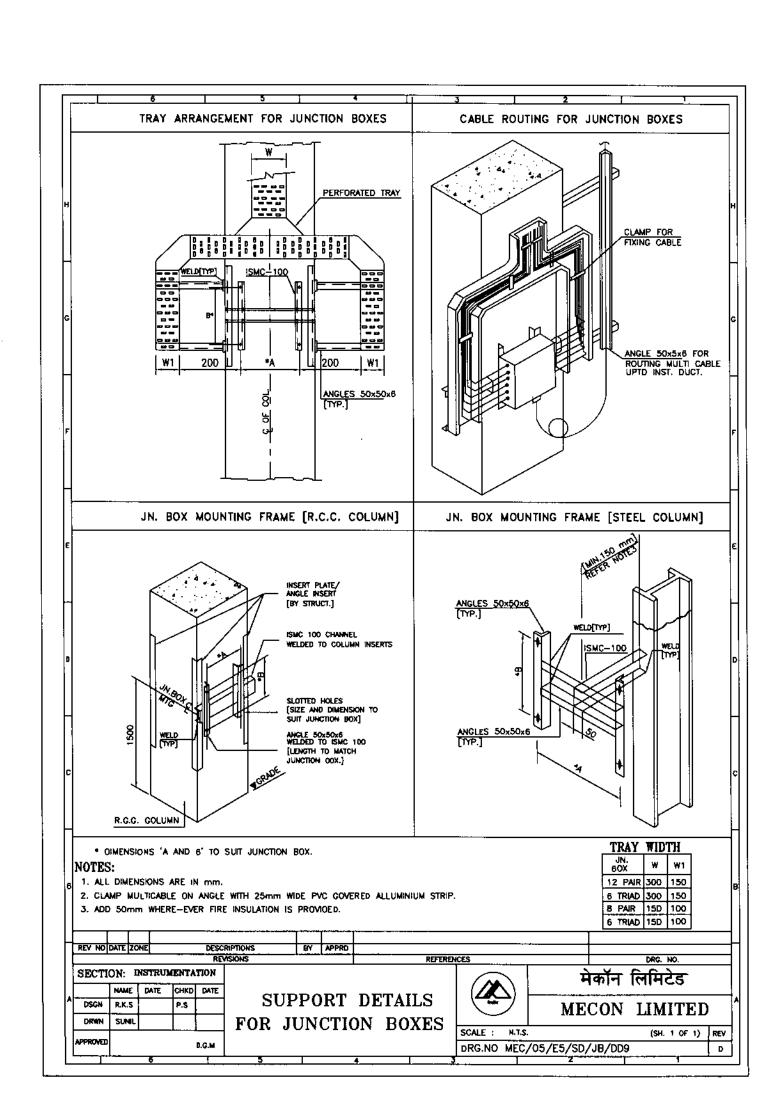


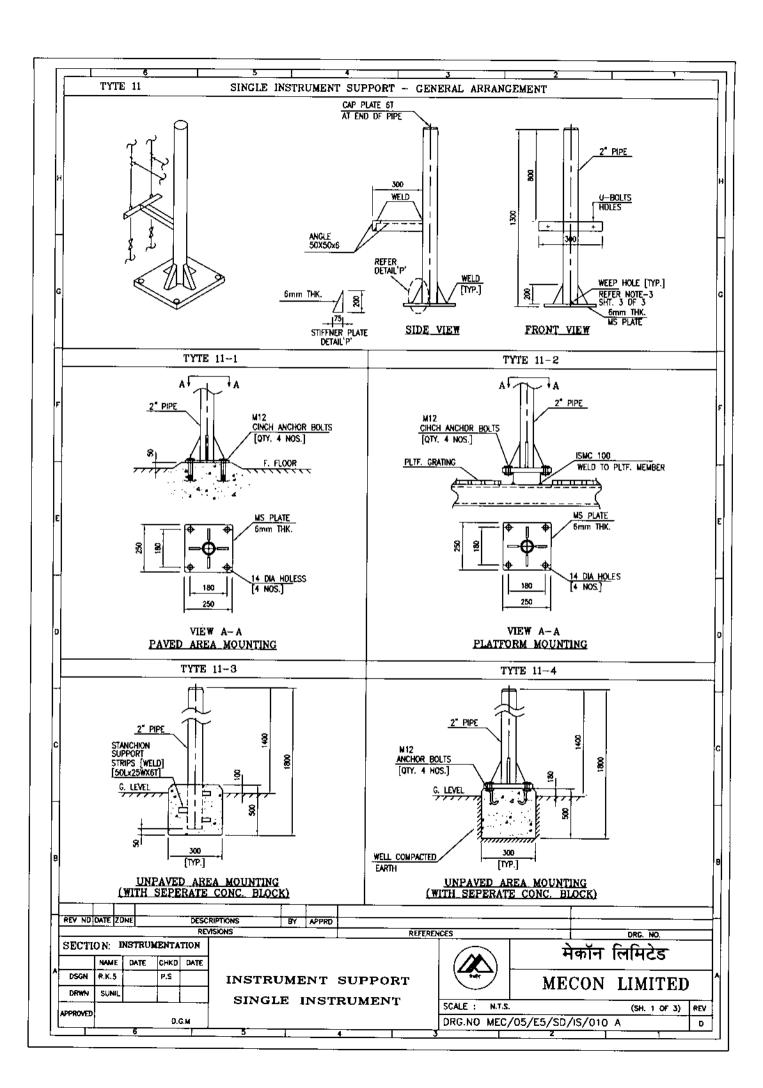


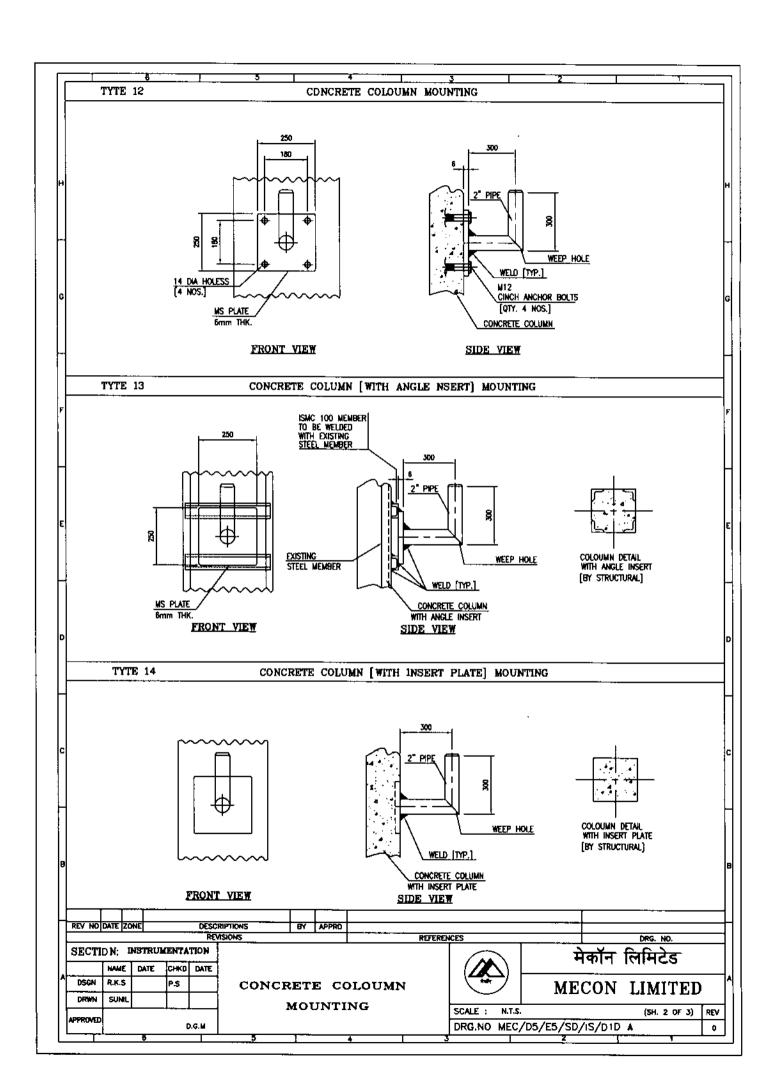


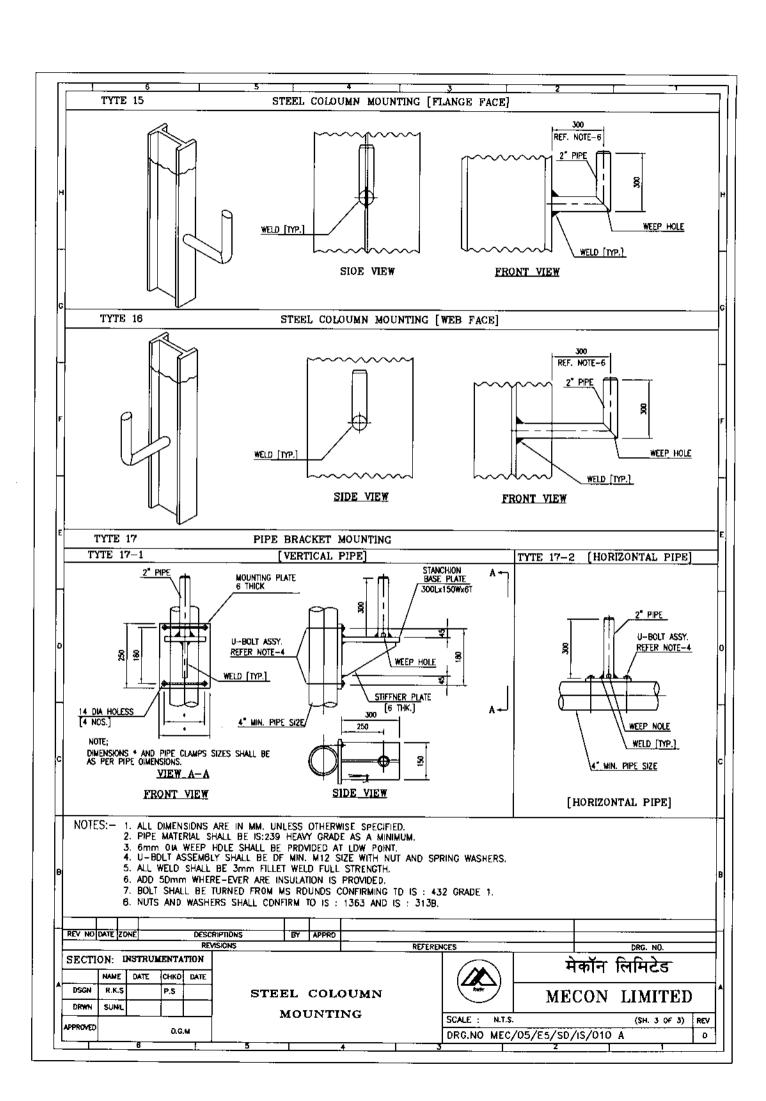


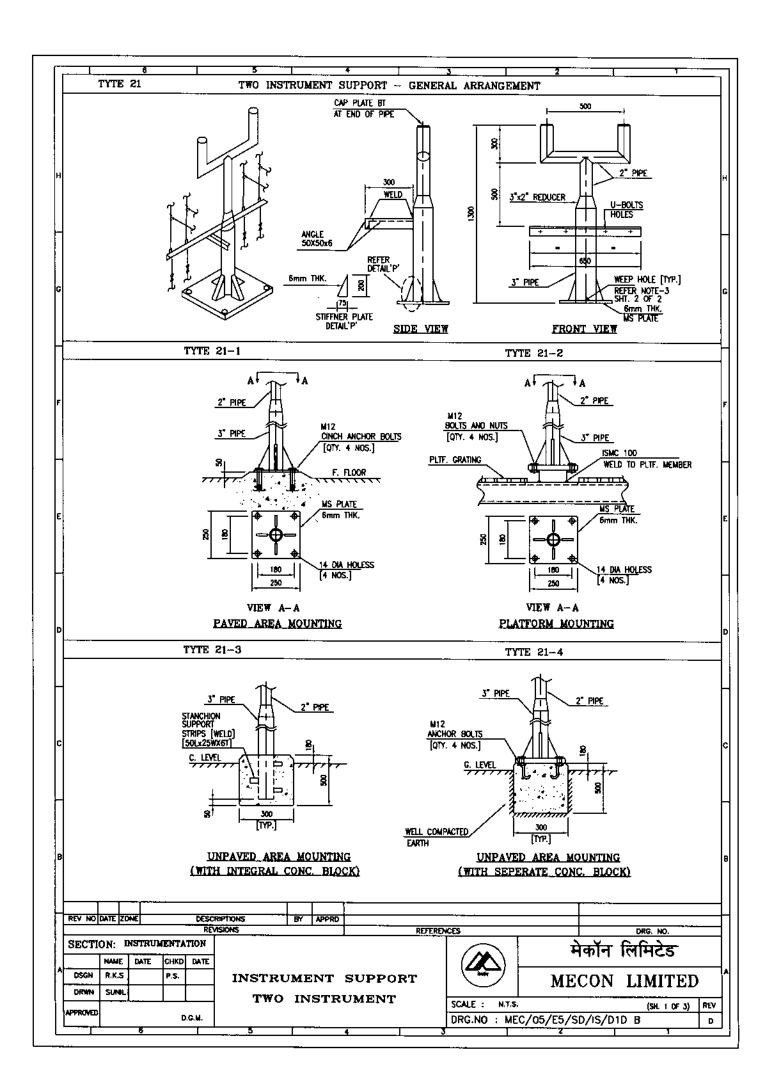

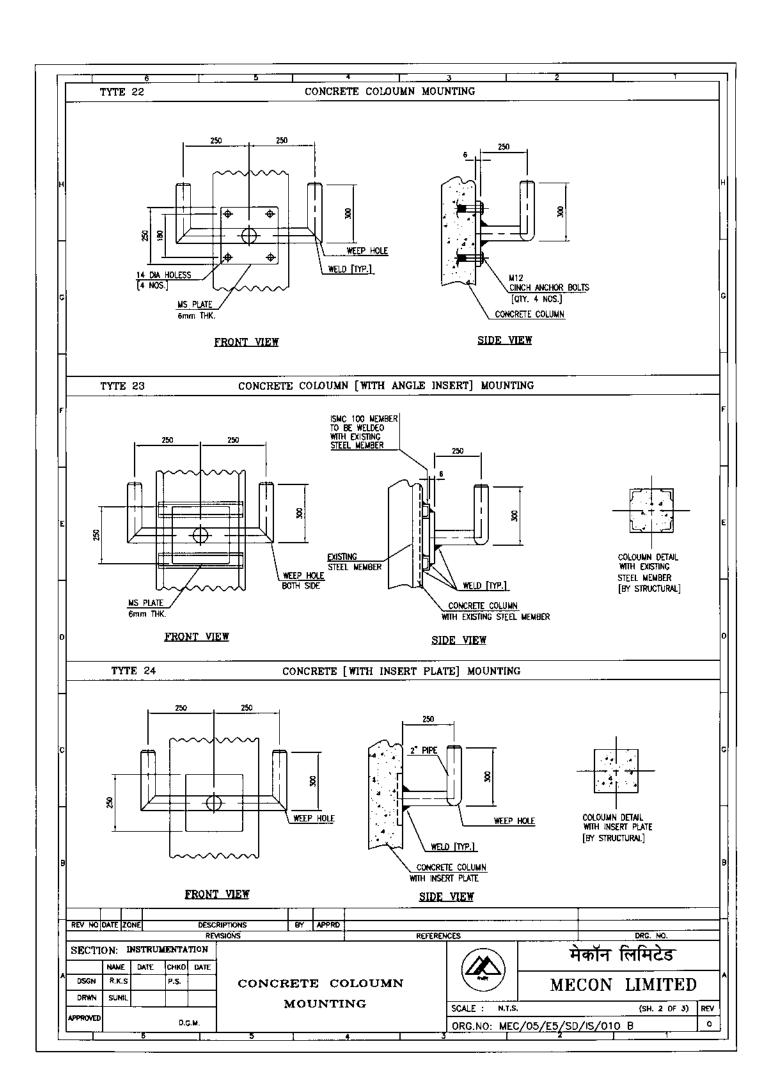

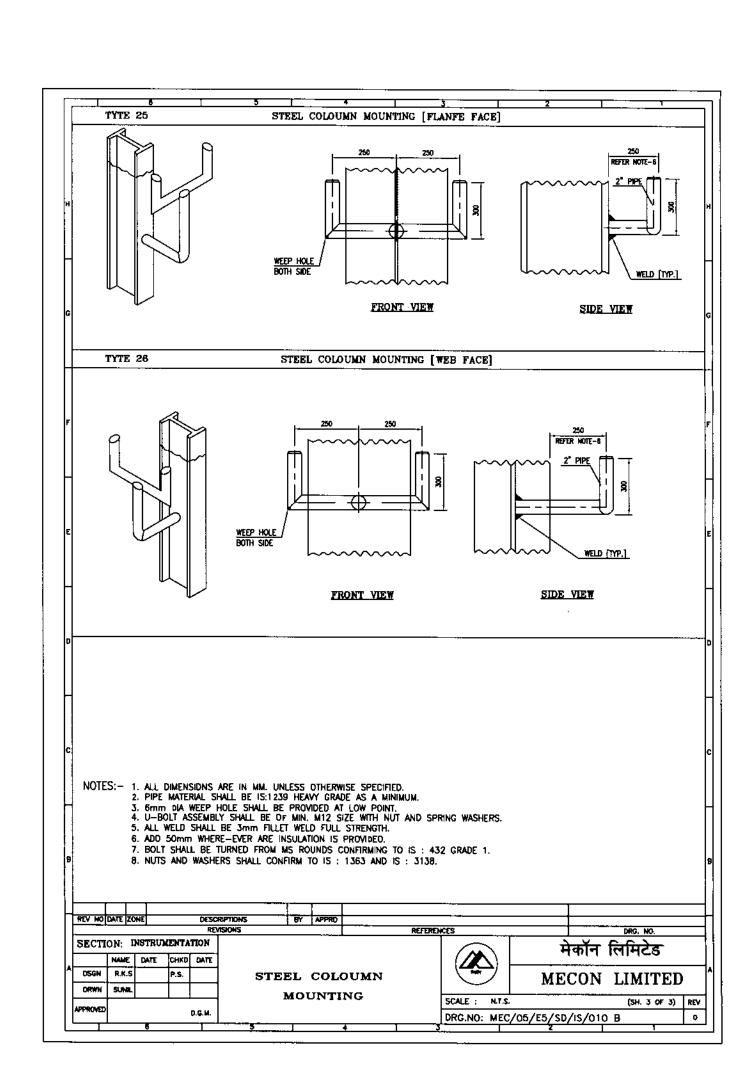

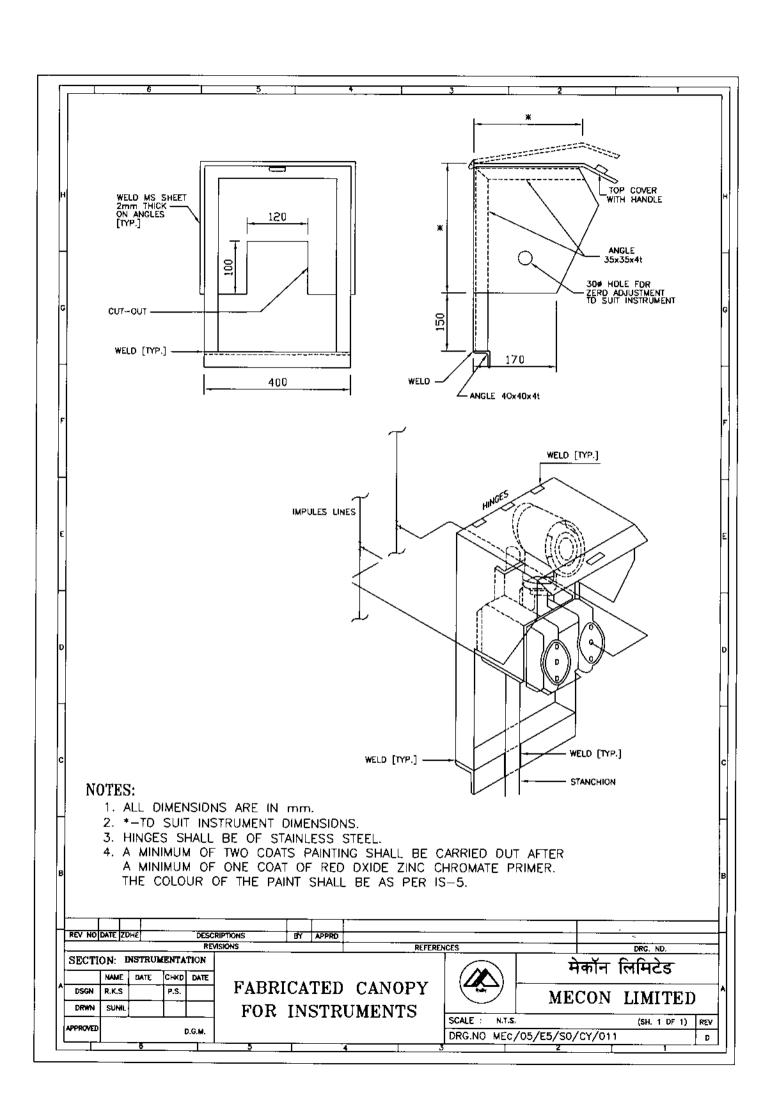

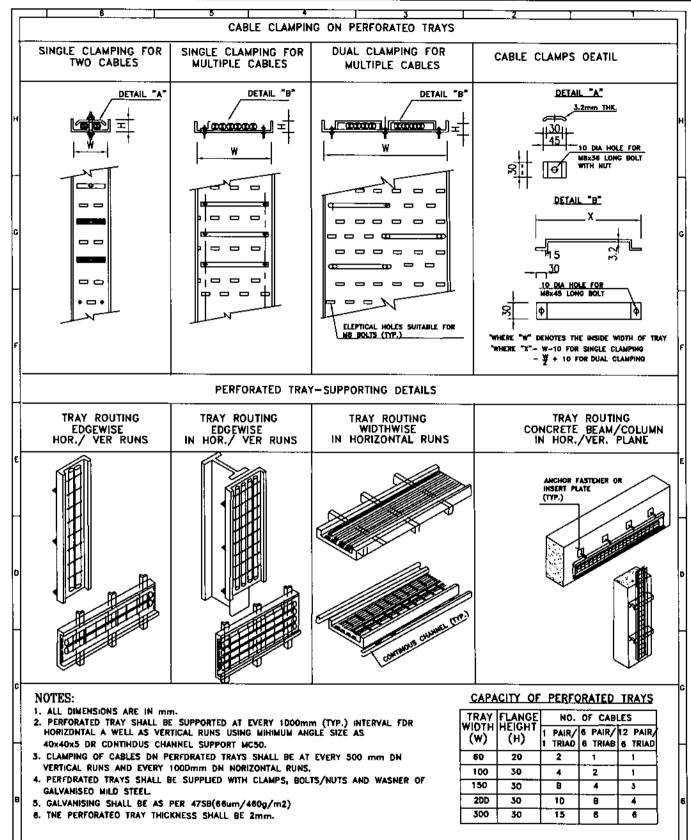

l	1		<u> </u>	T				1	1	l						-
Γ	REV NO	DATE	ZON	E			RIPTIONS	BY	APPRO	<u> </u>						$\dashv$
ı						RE	VISIONS				referen	KCES			DRG. NO.	
l	SECTION: INSTRUMENTATION											मेकॉन लिमिटे				
L		NA	Œ	DATE	CHKD	DATE								1111 1111 123		
^	DSGN	R.K	s		P.S		PERFORATED TRA			Y SUPPOR	RTS		ME(		CON LIMITED	
Ì	ORWN	SU	#L				& CAB	LES	CLAM!	PING DET	NG DETAILS					
١	APPROVED						1						SCALE : N.T.S.		(SH. 1 DF 1)	REV
l	APPROVED		D.G.M									DRG.NO ME	C/D5/E5/SD/	CB-LY/	/D12	0
L	I			6			5			4	3	т-	2		1	